
ABBREVIATIONS & SYMBOLOGY \bowtie WM **WATER METER TELEPHONE BLOW OFF HOSE BIB AIR RELEASE** SANITARY **WATER VAULT** REDUCER THRUST BLOCK **ABANDONED UTILITY UTILITY POLE PROPOSED ELECT. VAULT (T) TEL MANHOLE** TV **TEL VAULT TEL PEDESTAL CABLE RISER GAS METER GAS RISER GAS VALVE JUNCTION BOX** STREET LIGHT **POWER METER** SAN CLEANOUT SANITARY MANHOLE STORM CLEANOUT STORM MANHOLE **CATCH BASIN DECID TREE CONFIR TREE** **** IRON ROD RATE OF CURVATURE LATERAL APPROXIMATELY LINEAL FEET AMERICAN PUBLIC WORKS ASSOCIATION LONG SLEEVE LEFT ASSY **ASSEMBLY** LENGTH OF VERTICAL CURVE AWWA AMERICAN WATER WORKS ASSOCIATION BFV BUTTERFLY VALVE MAXIMUM MATERIAL ВО BLOW OFF BVCE MECHANICAL BEGIN VERTICAL CURVE ELEVATION BVCS BEGIN VERTICAL CURVE STATION MANUFACTURER C.O.B. CITY OF BEAVERTON MANHOLE CB CATCH BASIN MINIMUM CAST IRON MECHANICAL JOINT NOT IN CONTRACT CENTERLINE CMP ON CENTER CORRUGATED METAL PIPE

SW 158TH AVENUE STORM PRETREATMENT STRUCTURE CITY OF BEAVERTON **PUBLIC UTILITY IMPROVEMENT**




PUBLIC WORKS DEPARTMENT

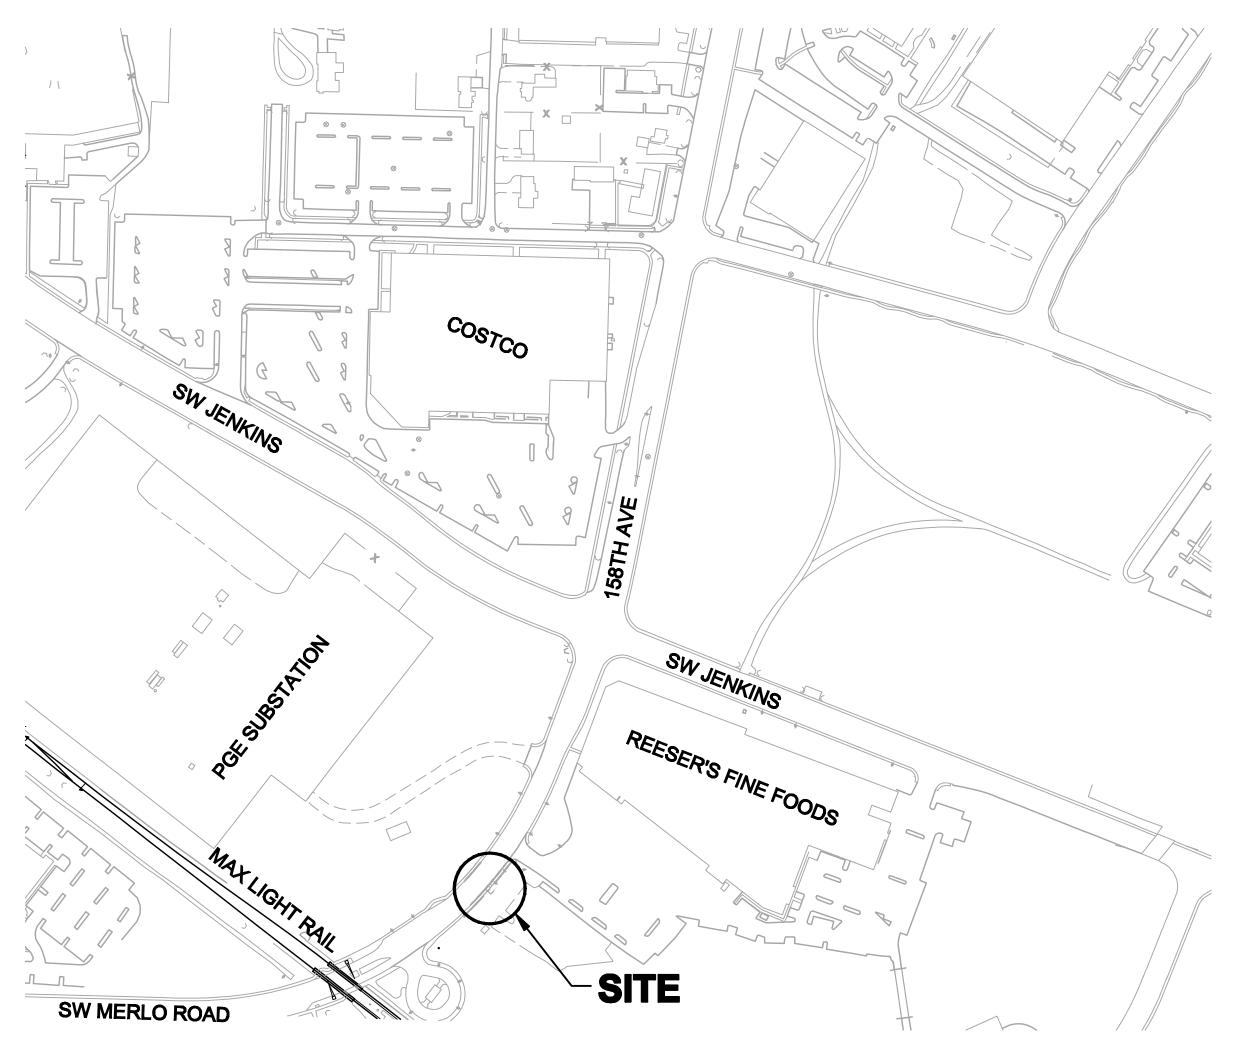

PROJECT SITE MAP

1" = 200'

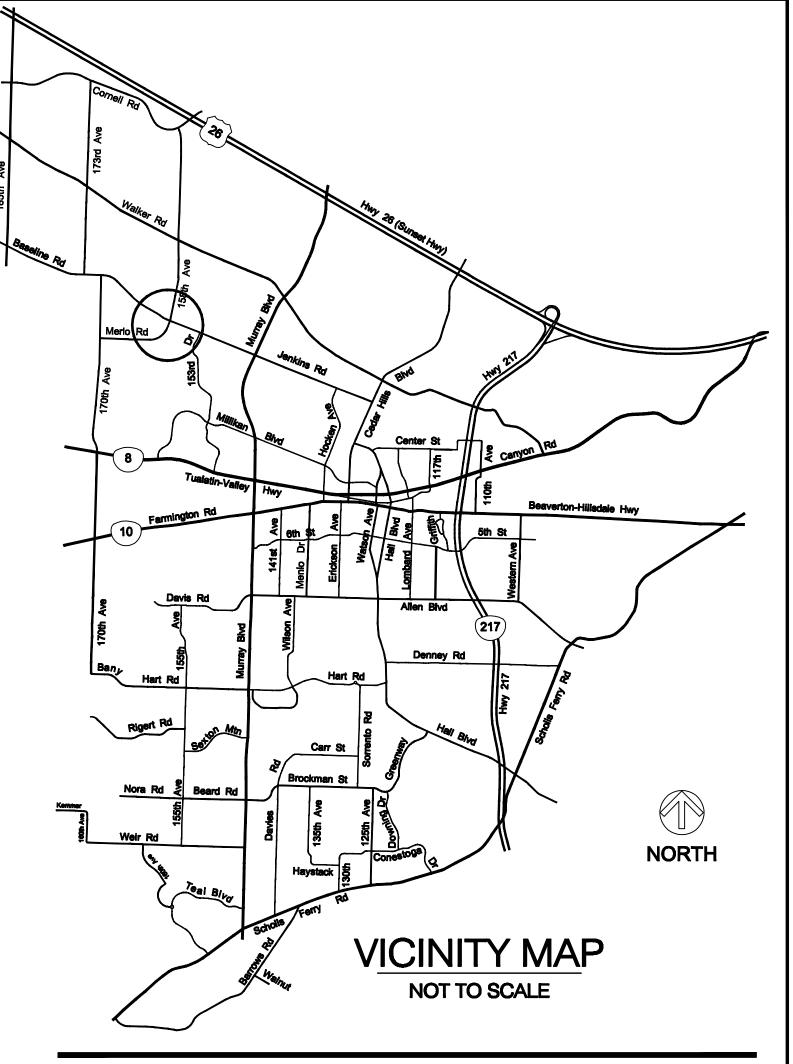

POTENTIAL UNDERGROUND FACILITY OWNERS

DIG SAFELY **CALL THE OREGON ONE-CALL CENTER**

1-800-332-2344

EMERGENCY TELEPHONE NUMBERS

NW NATURAL GAS
M-F 7am-5pm 503-226-4211 EXT.4313
AFTER HOURS 503-226-4211 503-226-4211 PGE QWEST VERIZON 503-464-7777 1-800-573-1311 1-800-483-1000

NOTICE TO EXCAVATORS

ATTENTION: OREGON LAW REQUIRES YOU TO FOLLOW RULES ADOPTED BY THE OREGON UTILITY NOTIFICATION CENTER. THOSE RULES ARE SET FORTH IN OAR 952-001-0010 THROUGH OAR 952-001-0090. YOU MAY OBTAIN COPIES OF THE RULES BY CALLING THE

(NOTE: THE TELEPHONE NUMBER FOR THE OREGON UTILITY NOTIFICATION CENTER IS (503)-232-1987).

RELEASES AND SHEET INDEX



EXPIRATION DATE: 12/31/

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-							
		CIVIL PLANS					
•	•	1	TITLE SHEET				
•		2	GENERAL NOTES				
•		3	STORM PLAN & PROFILE				
•		4	DETAILS				
•		5	VAULT SHOP DRAWINGS				

PROJECT INTENT - PRETREATMENT OF SURFACE WATER RUNOFF. CONSTRUCTED BY CITY FORCES

NAD 83 OREGON STATE PLANE, NORTH ZONE, INTERNATIONAL FOOT



CO

CONC

CPLG

CU

CWS

DEFL

DTL

DIA

EG

EQ

ESMT

EVCE

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FG

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FLG

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HYD

EX, EXTG

EL, ELEV

CLEANOUT

CONCRETE

COUPLING

CLEAN WATER SERVICES

COPPER

DEFLECT

DIAMETER

ELEVATION

EASEMENT

EXISTING

FITTING

FLEXIBLE

FLANGE

FLOOR FLOW LINE

GRADE

GAS

EQUAL

DUCTILE IRON

EXISTING GRADE

EDGE OF PAVEMENT

FINISHED GROUND

FIRE HYDRANT

GALVANIZED

GATE VALVE

HYDRANT

IRON PIPE

GRADE BREAK

INVERT ELEVATION

END VERTICAL CURVE ELEVATION

END VERTICAL CURVE STATION

HIGH DENSITY POLYETHYLENE

DETAIL

CITY OF BEAVERTON **PUBLIC WORKS DEPARTMENT ENGINEERING DIVISION**

OUTSIDE DIAMETER

POLYVINYL CHLORIDE

PRESSURE REDUCING VALVE

REINFORCED CONCRETE PIPE

REINFORCE(D) (ING) (MENT)

POINT OF VERTICAL INTERSECTION

POWER

PAVEMENT

REDUCER

REQUIRED

SIDEWALK

SCHEDULE

SLEEVE

STATION

STORM DRAIN

RESTRAINED

RIM ELEVATION

SANITARY SEWER

SANITARY SEWER

THRUST BLOCK TOP BACK CURE

TOP FACE CURB

TELEPHONE

TEMPORARY

THREAD(ED)

TYPICAL

VALVE

WATER

UNKNOWN

RESTR

RIM

S/W

STA

RIGHT-OF-WAY

DESIGNED BY:	MB	NO.	DATE	REVISION	BY
DRAWN BY:	AB	1	10/06/09	CONSTRUCTION SET — ADJUSTED TO FIT VAULT SHOP DRAWINGS	МВ
CHECKED BY:	MB				
APPROVED BY:	MB				

SW 158TH AVENUE - STORM PRETREATMENT STRUCTURE

NORTH

TITLE SHEET

DATE: 8/04/09	PROJECT NO: 8073
SHEET NO:	

GENERAL CONSTRUCTION NOTES

- THE CONTRACTOR SHALL NOTIFY THE CITY INSPECTOR AT LEAST 48 HOURS (TWO FULL WORKING DAYS) PRIOR TO BEGINNING THE PROJECT. CONNECTIONS BETWEEN EXISTING INFRASTRUCTURE AND NEW WORK SHALL NOT BE MADE UNTIL NECESSARY INSPECTIONS AND TESTS HAVE BEEN COMPLETED ON THE NEW WORK AND IT IS FOUND TO CONFORM IN ALL RESPECTS TO THE REQUIREMENTS OF THE PLANS AND SPECIFICATIONS.
- 2. CONTRACTOR SHALL VERIFY LOCATION AND DEPTH OF ALL EXISTING UTILITIES WHERE FACILITIES CROSS. CONTRACTOR SHALL POT HOLE EXISTING UTILITIES 200 FEET AHEAD OF LAYING PIPE AT ALL CROSSINGS. IF CONFLICTS ARISE. THE CONTRACTOR SHALL NOTIFY THE OWNER'S REPRESENTATIVE PRIOR TO CONSTRUCTION. UTILITY LOCATE ONE CALL # 1-800-332-2344
- 3. ALL CONSTRUCTION IS TO BE PERFORMED IN ACCORDANCE WITH THE MOST RECENT VERSION OF CITY OF BEAVERTON STANDARDS, OREGON APWA/ODOT STANDARD SPECIFICATIONS, CLEAN WATER SERVICES (CWS) STANDARDS (INCLUDING EROSION PREVENTION AND SEDIMENT CONTROL) AND THE OREGON ADMINISTRATION RULES (OAR), CHAPTER 333, UNLESS NOTED ON THE PLANS OR SPECIFIED
- 4. ALL EXISTING UTILITIES DISTURBED BY CONTRACTOR SHALL BE REPAIRED IMMEDIATELY AND THE RESPECTIVE UTILITY COMPANY NOTIFIED OF THE DISTURBANCE WITHOUT DELAY.
- 5. CONTRACTOR SHALL SUBMIT "AS-BUILT" INFORMATION TO THE OWNER'S REPRESENTATIVE UPON COMPLETION OF CONSTRUCTION.
- 6. THE CONTRACTOR SHALL NOT DAMAGE OR CUT EXISTING A.C. PIPE. EXCAVATE AND EXPOSE EXISTING A.C. PIPE UNTIL APPROPRIATE JOINTS ARE EXPOSED. DISCONNECT THE A.C. PIPE JOINT AND REMOVE THE APPROPRIATE SECTIONS OF A.C. PIPE WITHOUT CUTTING OR DAMAGING THEM. DISPOSE OF REMOVED A.C. PIPE IN A LEGAL MANNER AND IN CONFORMANCE WITH THE REQUIREMENTS OF AUTHORITIES CONTROLLING AIR POLLUTION AND SOLID WASTE DISPOSAL. CONTRACTOR SHALL COMPLY WITH APPLICABLE REQUIREMENTS OF OREGON REVISED STATUTES (ORS) 468A.700 THROUGH 468A-760.
- 7. FINAL LOCATIONS OF ALL VALVES AND VALVE BOXES, FIRE HYDRANTS, AIR RELEASE ASSEMBLIES, SERVICE CONNECTION CORP STOPS, DRIVEWAY APRONS, SEWER LATERALS, PERMANENT SIGNS, AND CATCH BASINS SHALL BE FIELD LOCATED. THE CONTRACTOR SHALL COORDINATE FINAL LOCATIONS OF THE DESCRIBED ITEMS WITH THE OWNER'S REPRESENTATIVE.
- 8. UTILITY CONSTRUCTION SEQUENCING WILL BE REQUIRED IN ORDER TO PREVENT CONFLICTS WITH EXISTING UTILITIES REMAINING IN SERVICE UNTIL NEWLY INSTALLED UTILITIES ARE CONNECTED AND IN SERVICE. CONTRACTOR SHALL SEQUENCE UTILITY WORK INCLUDING TEMPORARY CONNECTIONS AND BYPASSES AS REQUIRED SUCH AS TO MINIMIZE DISRUPTION OF SERVICES. SEE SECTION 105.4.01WITHIN THE SPECIFICATIONS REGARDING CONSTRUCTION SEQUENCING REQUIREMENTS FOR THIS PROJECT.
- 9. MAINTENANCE OF THE WORK AREA AND APPROACH ROADS IS THE RESPONSIBILITY OF THE CONTRACTOR. THE WORK AREA AND APPROACH ROADS SHALL BE MAINTAINED IN A CLEAN CONDITION, FREE FROM OBSTRUCTIONS AND HAZARDS.
- 10. ANY CHANGE IN CONSTRUCTION AFTER PLAN APPROVAL MUST BE SUBMITTED IN WRITING AND APPROVED BY THE CITY PRIOR TO CHANGE.
- 11. AT THE END OF EACH WORK DAY ALL TRENCHES SHALL BE BACKFILLED AND ALL TRENCHES WITHIN STREETS SHALL BE TEMPORARY PAVED OR COVERED TO THE SATISFACTION OF THE OWNER'S REPRESENTATIVE. STEEL SHEET PLACEMENTS SHALL BE LIMITED TO 36 HOURS IN ANY ONE LOCATION. BEYOND 36 HOURS, EXCAVATIONS SHALL BE PAVED. AC PAVEMENT EITHER TEMPORARY OR PERMANENT, SHALL BE HOT MIX BITUMINOUS ASPHALT. NO TRENCH, ON-SITE OR OFF-SITE, SHALL BE LEFT AT ANY TIME IN AN UNSAFE CONDITION. THE CONTRACTOR IS RESPONSIBLE FOR AND IS LIABLE FOR HAZARDS OR DAMAGE RESULTING FROM THE PROSECUTION OF THE WORK.
- 12. EFFECTIVE EROSION CONTROL, DUST CONTROL, AND DRAINAGE CONTROL IS REQUIRED AT ALL TIMES. THE CONTRACTOR IS SOLELY RESPONSIBLE FOR PROTECTION OF ALL WORK, ADJACENT PROPERTIES AND DOWNSTREAM FACILITIES FROM EROSION AND SILTATION DURING THE COURSE OF THE WORK. ANY DAMAGE RESULTING FROM SUCH EROSION AND SILTATION SHALL BE CORRECTED AT THE SOLE EXPENSE OF THE CONTRACTOR.
- 13. THE CONTRACTOR SHALL MAINTAIN ACCESS TO ALL DRIVEWAYS. IF A DRIVEWAY MUST BE BLOCKED. THE CONTRACTOR SHALL GIVE THE HOMEOWNER, APARTMENT MANAGER AND/OR BUILDING OWNER 24 HOURS NOTICE AND SHALL ENSURE ACCESS TO DRIVEWAYS AT THE END OF EACH WORK DAY.
- 14. THE CONTRACTOR SHALL EXERCISE ALL DUE CARE IN PROTECTING PROPERTY ALONG THE ROUTE OF THE IMPROVEMENTS. THIS PROTECTION SHALL INCLUDE, BUT NOT BE LIMITED TO, TREES, YARDS, FENCES, DRAINAGE LINES, MAIL BOXES, DRIVEWAYS, SHRUBS, LAWNS, IRRIGATION SYSTEMS, WITHIN ANY RIGHTS-OF-WAYS AND EASEMENTS. IF ANY OF THE ABOVE HAVE BEEN DISTURBED, THEY SHALL BE RESTORED AS NECESSARY TO AS NEAR THEIR ORIGINAL CONDITION AS POSSIBLE OR REPLACED IN KIND.
- 15. ALL SURVEY MONUMENTS SHALL BE LOCATED AND PROTECTED, EXCEPT AS SPECIFICALLY DIRECTED BY THE CITY ENGINEER.
- 16. THE CONTRACTOR SHALL PERFORM ALL THE WORK SHOWN ON THE DRAWINGS AND ALL INCIDENTAL WORK CONSIDERED NECESSARY TO COMPLETE THE PROJECT IN AN ACCEPTABLE MANNER.
- 17. THE CONTRACTOR AND OR SUB-CONTRACTOR SHALL HAVE A MINIMUM OF ONE SET OF CITY APPROVED CONSTRUCTION PLANS ON THE JOB SITE AT ALL TIMES DURING EACH CONSTRUCTION PHASE WHILE **WORK IS BEING DONE.**
- 18. ALL MATERIAL SUPPLIERS SHALL SUBMIT TO THE ENGINEER PROOF OF MATERIAL(S) TESTED IN ACCORDANCE WITH SPECIFICATIONS. BY ACCEPTANCE OF THE CONTRACT WITH THE OWNER/DEVELOPER, THE CONTRACTOR CERTIFIES THAT ALL MATERIALS DELIVERED TO THE JOB SITE WILL MEET OR EXCEED THOSE SPECIFICATIONS. ANY MATERIAL NOT CONFORMING SHALL BE REMOVED FROM THE SITE AT NO ADDITIONAL COST TO THE OWNER.
- 19. UPON COMPLETION OF THE WORK, THE CONTRACTOR SHALL LEAVE THE PROJECT AREA FREE OF DEBRIS AND UNUSED MATERIALS.


ENGINEERING DIVISION

TRAFFIC CONTROL NOTES

- 1. TRAFFIC CONTROL TO BE PERFORMED IN ACCORDANCE WITH THE MANUAL FOR UNIFORM TRAFFIC CONTROL DEVICES AND OREGON AMENDMENTS AS REQUIRED. THE CITY CAN REQUIRE ADDITIONAL TRAFFIC CONTROL MEASURES AS NEEDED TO PROVIDE FOR PUBLIC SAFETY.
- 2. ON RESIDENTIAL LOCAL STREETS, THE CONTRACTOR SHALL BE RESPONSIBLE TO PROVIDE ALL REQUIRED TRAFFIC CONTROL WHEN WORK IS BEING DONE IN THE RIGHT OF WAY.
- 3. ALL TRAFFIC CONTROL MEASURES NEED TO BE SUBMITTED TO THE CITY OF BEAVERTON FOR REVIEW AT LEAST 5 (FIVE WORKING DAYS PRIOR TO CONSTRUCTION. ALL STREET CLOSURES SHALL BE APPROVED BY THE CITY TRAFFIC ENGINEER, AT LEAST 5 (FIVE) WORKING DAYS IN ADVANCE.
- 4. UPON APPROVAL, THE CONTRACTOR SHALL NOTIFY THE BEAVERTON POLICE DEPARTMENT, TUALATIN VALLEY FIRE AND RESCUE AND THE BEAVERTON SCHOOL DISTRICT TRANSPORTATION OFFICE AT LEAST 48 HOURS IN ADVANCE OF ANY STREET CLOSURE.
- 5. TRAFFIC CONTROL PLANS SHALL COMPLY WITH THE OREGON DEPARTMENT OF TRANSPORTATION -"SHORT TERM TRAFFIC CONTROL HANDBOOK". TRAFFIC CONTROL DEVICES SHALL COMPLY WITH THE "MANUAL ON UNIFORM TRAFFIC CONTROL DEVICES" PREPARED BY THE FEDERAL HIGHWAY ADMINISTRATION, LATEST REVISION. CONTRACTOR SHALL COMPLY WITH ALL CONDITIONS SPECIFIED IN ROAD PERMITS ISSUED FOR THIS PROJECT.
- 6. CONTRACTOR SHALL COORDINATE ALL STREET AND SIDEWALK CLOSURES WITH THE CITY. CONTRACTOR SHALL SUPPLY SIGNING AND BARRICADES AS REQUIRED TO ASSURE AUTOMOTIVE AND PEDESTRIAN SAFETY.

EROSION CONTROL STANDARD NOTES

- 1. APPROVAL OF THIS EROSION/SEDIMENTATION CONTROL (ESC) PLAN DOES NOT CONSTITUTE AN APPROVAL OF PERMANENT ROAD OR DRAINAGE DESIGN (E.G. SIZE AND LOCATION OF ROADS, PIPES, RESTRICTORS, CHANNELS, RETENTION FACILITIES, UTILITIES, ETC.).
- 2. THE IMPLEMENTATION OF THESE ESC PLANS AND THE CONSTRUCTION, MAINTENANCE, REPLACEMENT, AND UPGRADING OF THESE ESC FACILITIES IS THE RESPONSIBILITY OF THE APPLICANT/CONTRACTOR UNTIL ALL CONSTRUCTION IS COMPLETED AND APPROVED AND VEGETATION/LANDSCAPING IS ESTABLISHED.
- 3. THE ESC FACILITIES SHOWN ON THIS PLAN MUST BE CONSTRUCTED IN CONJUNCTION WITH ALL CLEARING AND GRADING ACTIVITIES, AND IN SUCH A MANNER AS TO INSURE THAT SEDIMENT LADEN WATER DOES NOT ENTER THE DRAINAGE SYSTEM OR VIOLATE APPLICABLE WATER STANDARDS.
- 4. THE ESC FACILITIES SHOWN ON THIS PLAN ARE THE MINIMUM REQUIREMENTS FOR ANTICIPATED SITE CONDITIONS. DURING THE CONSTRUCTION PERIOD, THESE ESC FACILITIES SHALL BE UPGRADED AS NEEDED FOR UNEXPECTED STORM EVENTS AND TO ENSURE THAT SEDIMENT-LADEN WATER DOES NOT LEAVE THE SITE.
- 5. THE ESC FACILITIES SHALL BE INSPECTED DAILY BY THE APPLICANT/CONTRACTOR AND MAINTAINED AS NECESSARY TO ENSURE THEIR CONTINUED FUNCTIONING.
- 6. THE ESC FACILITIES ON INACTIVE SITES SHALL BE INSPECTED AND MAINTAINED A MINIMUM OF ONCE A MONTH OR WITHIN THE 24 HOURS FOLLOWING A STORM EVENT.
- 7. AT NO TIME SHALL MORE THAN ONE FOOT OF SEDIMENT BE ALLOWED TO ACCUMULATE WITHIN A TRAPPED CATCH BASIN. ALL CATCH BASINS AND CONVEYANCE LINES SHALL BE CLEANED PRIOR TO PAVING. THE CLEANING OPERATION SHALL NOT FLUSH SEDIMENT LADEN WATER INTO THE DOWNSTREAM SYSTEM.
- 8. STABILIZED CONSTRUCTION ENTRANCES SHALL BE INSTALLED AT THE BEGINNING OF CONSTRUCTION AND MAINTAINED FOR THE DURATION OF THE PROJECT. ADDITIONAL MEASURES MAY BE REQUIRED TO INSURE THAT ALL PAVED AREAS ARE KEPT CLEAN FOR THE DURATION OF THE PROJECT.

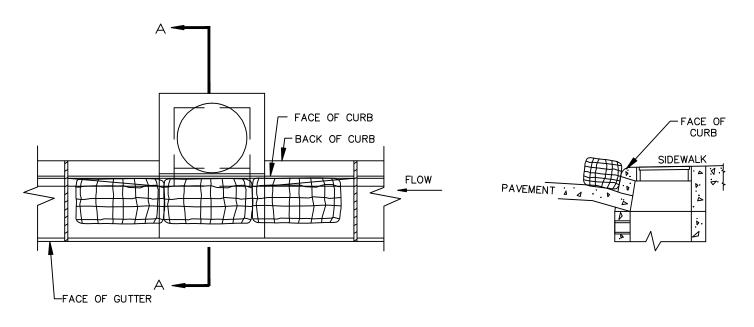

PLAN VIEW

SECTION A-A

. FOR USE IN SHORT TERM APPLICATIONS ONLY.

A MINIMUM OF ONCE A MONTH OR WITHIN 48 HRS OF A STORM EVENT.

C. CONTRACTOR RESPONSIBLE FOR ADEQUATE NUMBER OF HAY BALES. PROVIDE ONE FULL BALE EACH SIDE OF CURB OPENING WITH NO GAPS OR OPENINGS IN CONTROL DEVICE. 3. THE SEDIMENT CONTROL DEVICE SHALL BE INSPECTED DAILY BY THE CONTRACTOR AND MAINTAINED

> **BIO-BAG INLET BARRIER** AT CURB INLET



PROJECT INTENT - PRETREATMENT OF SURFACE WATER RUNOFF. CONSTRUCTED BY CITY FORCES NAD 83 OREGON STATE PLANE, NORTH ZONE, INTERNATIONAL FOOT

CITY OF BEAVERTON **PUBLIC WORKS DEPARTMENT**

NO. DATE **REVISION DESIGNED BY:** BY MB **DRAWN BY:** 10/06/09 CONSTRUCTION SET - ADJUSTED TO FIT VAULT SHOP DRAWINGS CHECKED BY: MB APPROVED BY:

SW 158TH AVENUE - STORM PRETREATMENT STRUCTURE

GENERAL NOTES

DATE: PROJECT NO: 8/04/09 8073 SHEET NO:

STORM NOTES

- 1 PROTECT EXISTING PAVEMENT, SIDEWALK, AND GUTTER AT ALL TIMES.
- REMOVE EXISTING TREE. EXCAVATE OUT AROUND ROOT BALL AND SET ASIDE TO REPLANT AT END OF PROJECT. DETERMINE IN FIELD IF TREE CAN BE SAVED AT TIME OF EXCAVATION AND PROJECT COMPLETION. REPLACE TREE WITH SIMILAR TYPE AND SIZE IF EX TREE IS NOT SALVAGEABLE.
 - SUSPECTED ELECTRICAL LINE LOCATIONS FOR STREET LIGHTS AND/OR TRAFFIC SIGNALS. LOCATE TICKET #9089042 MAY 8TH, 2009. STREET LIGHT AND TRAFFIC SIGNALS CONDUITS WERE NOT LOCATED BY RESPECTIVE OWNER. KEVEN ELLINGTON (WACO) CALLED ON 8-5-09 AND STATED THAT WACO WOULD PROVIDE LOCATES FOR STREET AND SIGNAL CONDUITS. PHONE: 503-846-7954.
- (4) EXISTING CATCH BASIN TO REMAIN.
- 1+45.00 = BACK OF SIDEWALK AT CB. CAN BE USE AS A REFERENCE DURING CONSTRUCTION. ELEV=191.75
- 6) PROTECT EXISTING STORM MANHOLE AT ALL TIMES
- (7) INSTALL ORANGE CONSTRUCTION FENCING.
- 8) INSTALL SEDIMENT FENCE. TO BE IN PLACE IF RAIN IS FORECASTED.
- 9) INSTALL INLET PROTECTION. INSTALL INLET PROTECTION AT NEXT DOWN STREAM INLET (IF ANY).
- POSSIBLE IRRIGATION SYSTEM IN AREA. USE CAUTION WHILE EXCAVATING. DAMAGED SECTIONS MUST BE REPAIRED.

- INSTALL TREATMENT VAULT. INSTALL EDGE OF VAULT 2.0' FROM SIDEWALK EDGE. SEE VAULT DETAILS.
- REMOVE AND RELAY EX PIPE SECTIONS AND BEND PIPE AT JOINTS TO MAKE PIPE CONNECTION TO VAULT WORK. DETERMINE IN FIELD.
- (13) REMOVE EXISTING SECTION OF STORM PIPE.
- (14) INSTALL NEW STORM PIPE. SEE PROFILE.

196 EX. GROUND AT PIPE -EX. GROUND AT PIPE 24" STM 190 **QS=**0.0267 EX 41.2' OF 30" RCP @ 0.0079 46.6' OF 10" RCP @ 0.0050 SIZE, IE, + SLOPE ASSUMED STA:1+36.45 188 ELEV:186.77 CUT & REMOVE EX STORM PIPE 184 SDC STA STA 10" II 30" I 80" I 188.6' OF 30' CSP @ 0.0159 182 180.75 BOTTOM VAULT STA SO." 30." 178

SDLN 01 PROFILE HORIZONTAL SCALE: 1"= 10 VERTICAL SCALE: 1"= 2

1+40

1+73

1+60

SUGGESTED CONSTRUCTION SEQUENCE

- 1. GET BIDS ON COMPETING STURCTURES (SHEET 4A VS 4B).
- 2. OBTAIN CORRECT SHOP DRAWINGS FROM SUCCESSFUL BIDDER. PROJECT ENGINEER TO APPROVE.
- 3. CALL FOR LOCATES.
- 4. INSTALL INLET PROTECTION, SEDIMENT FENCING, ORANGE CONSTRUCTION FENCING AS NECESSARY.
- 5. REMOVE EXISTING TREE. SEE CONSTRUCTION NOTES.
- 6. DETERMINE IF STREET LIGHTING CONDUIT, IRRIGATION LINES, OR OTHER CONDUIT EXISTS IN PROJECT AREA. CONTACT PROJECT ENGINEER IF CONDUITS EXIST. VAULT LOCATION MAY NEED FIELD LOCATION ADJUSTMENT IF CONDUITS EXIST.
- 7. EXCAVATE FOR UTILITY VAULT. OVER EXCAVATION WILL BE NEEDED FOR TRENCH SHORING, AND VAULT ADJUSTMENT.
- 8. CUT AND REMOVE EXISTING 30" PIPE. REMOVE PIPE TO BACK OF CATCH BASIN.
- 9. HAMMER AND REMOVE EXISTING CB WALL AS NEEDED TO PLACE NEW 24" LINE ALONG NEW ALIGNMENT, MATCH INVERT.
- 10. PLACE 24" PIPE ALONG ALIGNMENT, AND SLIP AS MUCH AS PRACTICAL INSIDE THE CATCH BASIN. DO NOT SET PIPE. PIPING WILL BE MOVED AND FINALIZED AFTER THE VAULT IS IN PLACE.

NOTE:


THE EXISTING 30" PIPE SIZE IS SUBSTANTIALLY LARGER THAN IT NEEDS TO BE TO CONVEY SURFACE WATER RUNOFF FROM THE ACTUAL TRIBUTARY AREA.

INSTALLATION OF 24" PIPE SHALL BE WATER TIGHT AT ALL JOINTS AND CONNECTIONS.

LOCATES CALL FOR ON MAY 8TH, 2009 LOCATE TICKET NUMBER 9089038.

SUGGESTED CONSTRUCTION SEQUENCE

- 11. DETERMINE ELEVATION BETWEEN VAULT BOTTOM AND IE OUT OF STRUCTURE. ADJUST EXCAVATION SO THAT THE NEW IE AND THE OUT IE MATCH (INCLUDE ROCK BASE NOTED BELOW).
- 12. PLACE APPROX 4" OF 3/4" MINUS FOR LEVELING PROPOSES, THEN COMPACT MATERIAL UNDER VAULT. CHECK IES, FILL OR EXCAVATE AND RECOMPACT AS NEEDED
- 13. SLIDE VAULT ONTO OUTLET STORM PIPE. ALIGN INLET AND VAULT INLET. SEAL JOINT BETWEEN VAULT AND PIPE AS NEEDED.
- 14. SLIDE 24" PIPE OUT OF CB AND INTO VAULT. SEAL JOINT BETWEEN VAULT AND PIPE AS NEEDED. RECONSTRUCT AND GROUT PIPE TO CATCH BASIN AS
- 15. FINISH INSTALLING VAULT STRUCTURES PER MANUFACTURES RECOMMENDATIONS.
- 16. BACKFILL AND COMPACT AS NEEDED AROUND VAULT.
- 17. REPLANT AND RESTORE SITE TO EQUIVALENT CONDITION PRIOR TO CONSTRUCTION.
- 18. REMOVE EROSION CONTROL MEASURES AND ORANGE CONSTRUCTION FENCING AFTER SOIL IS STABILIZED AND SITE IS NO LONGER A SAFETY HAZARD.
- 19. RESTORE LANDSCAPING AND IRRIGATION TO SATISFACTION OF STEVE BRENNAN.

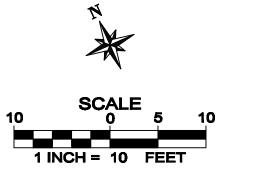



PROJECT INTENT - PRETREATMENT OF SURFACE
WATER RUNOFF. CONSTRUCTED BY CITY FORCES
NAD 83 OREGON STATE PLANE, NORTH ZONE, INTERNATIONAL FOOT

CITY OF BEAVERTON
PUBLIC WORKS DEPARTMENT
ENGINEERING DIVISION

DESIGNED BY:MBNO.DATEREVISIONBYDRAWN BY:AB110/06/09CONSTRUCTION SET — ADJUSTED TO FIT VAULT SHOP DRAWINGSMBCHECKED BY:MBAPPROVED BY:MB


1+20


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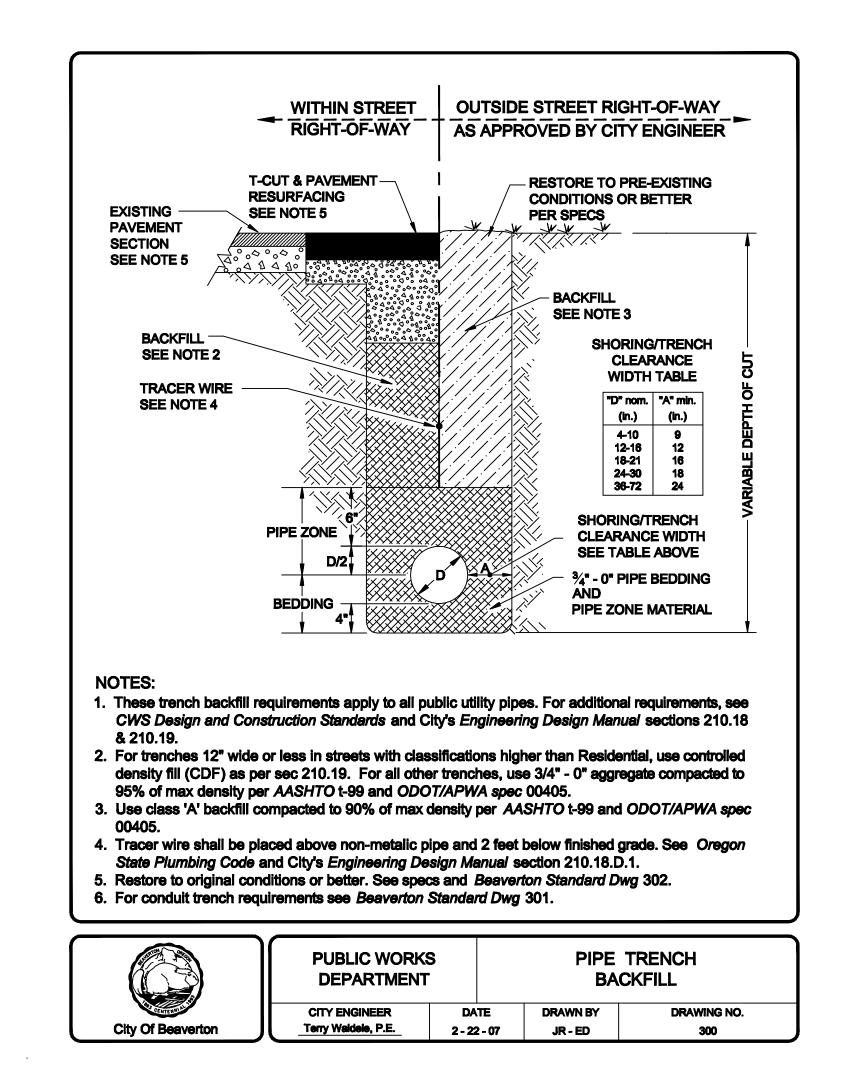
SW 158TH AVENUE - STORM PRETREATMENT STRUCTURE

STORM PLAN AND PROFILE

DATE: PROJECT NO: 8/04/09 8073
SHEET NO:



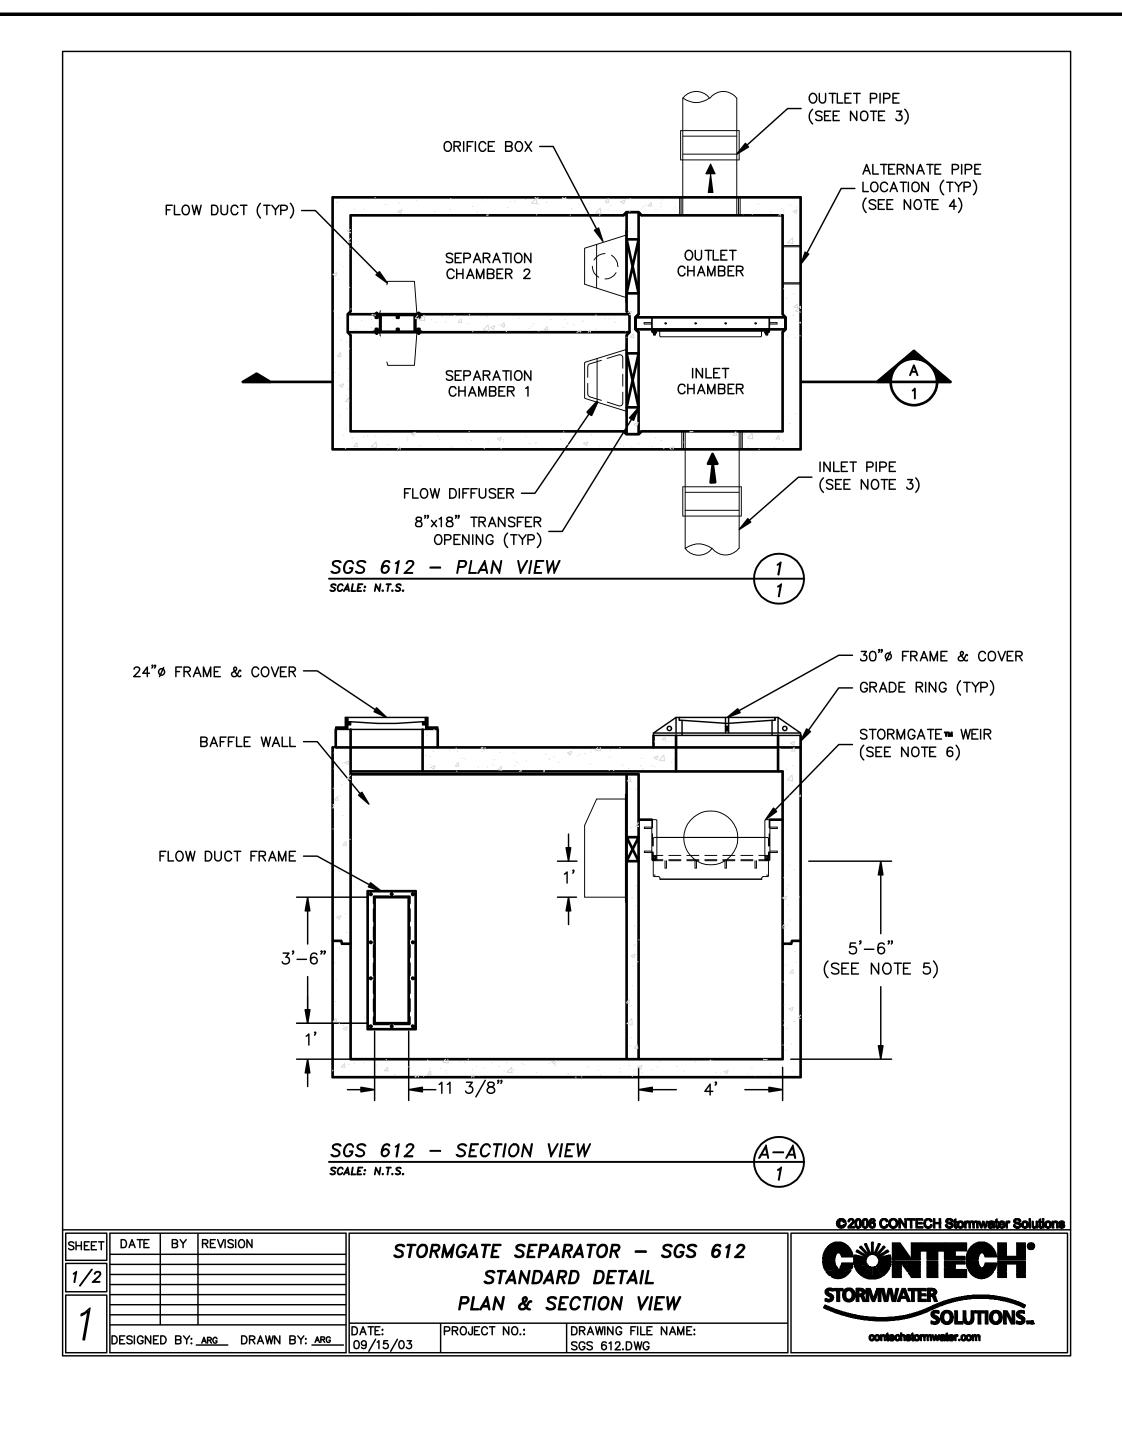

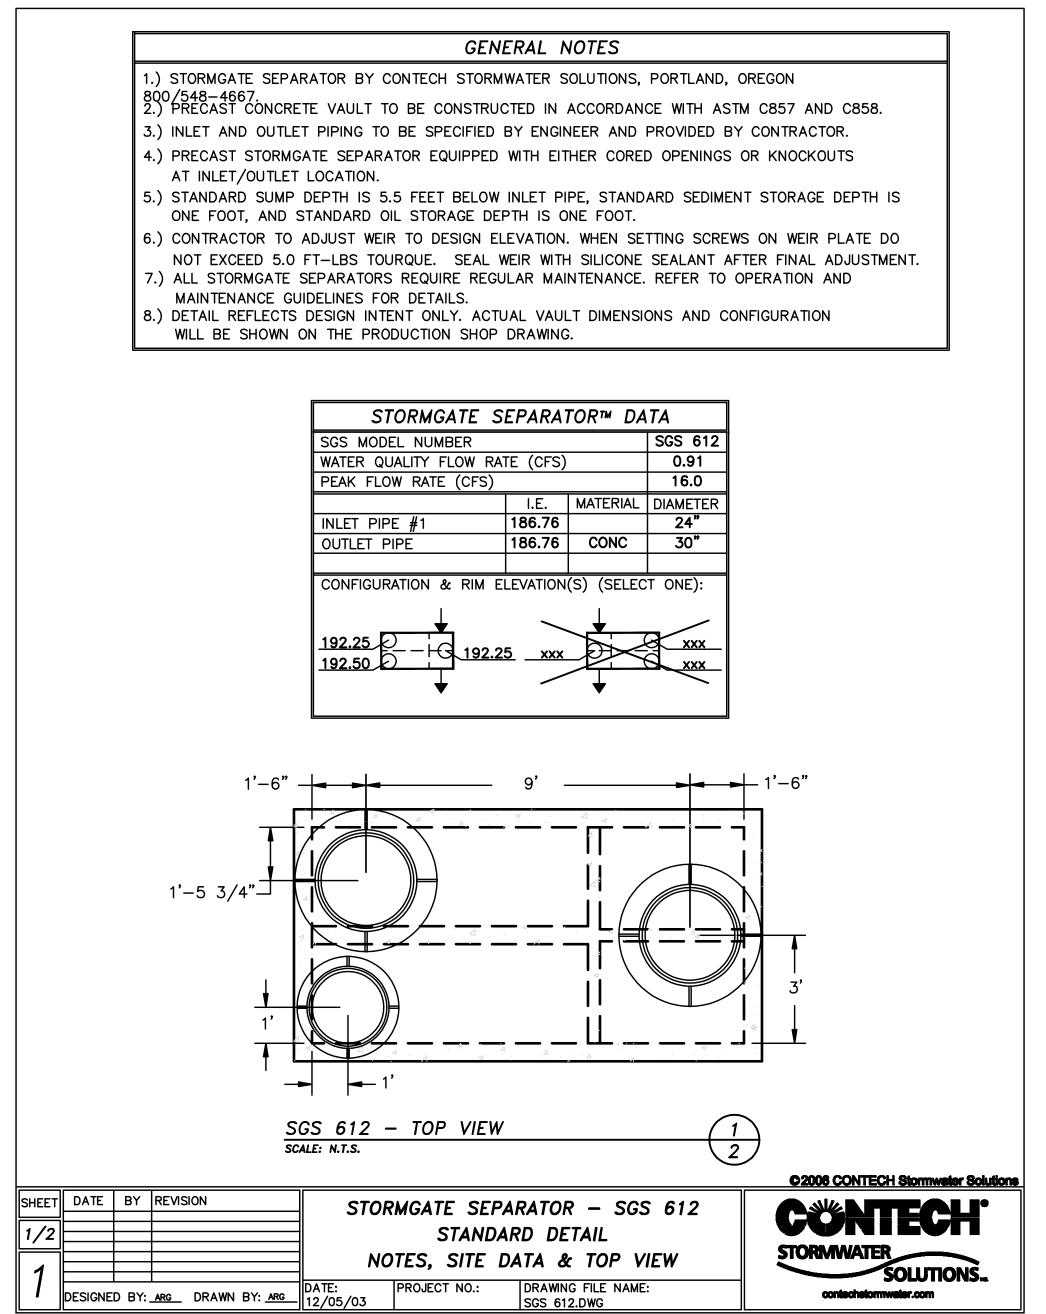



NOTES:

SEE PAGE 5 FOR SHOP DRAWINGS. ACTUAL VAULT **DIMENSIONS VARIED FROM THIS DETAIL.**

APPROXIMATELY 8 WEEK ORDER TIME. CALL FOR INFO.



PROJECT INTENT - PRETREATMENT OF SURFACE WATER RUNOFF. CONSTRUCTED BY CITY FORCES

NAD 83 OREGON STATE PLANE, NORTH ZONE, INTERNATIONAL FOOT



CITY OF BEAVERTON **PUBLIC WORKS DEPARTMENT ENGINEERING DIVISION**

DESIGNED BY:	MB	NO.	DATE	REVISION	BY
DRAWN BY:	AB	1	10/06/09	CONSTRUCTION SET — ADJUSTED TO FIT VAULT SHOP DRAWINGS	МВ
CHECKED BY:	MB				
APPROVED BY:	MB				

SW 158TH AVENUE - STORM PRETREATMENT STRUCTURE

DETAILS

DATE: 8/04/09	PROJECT NO: 8073
SHEET NO:	_

PROJECT INTENT - PRETREATMENT OF SURFACE WATER RUNOFF. CONSTRUCTED BY CITY FORCES NAD 83 OREGON STATE PLANE, NORTH ZONE, INTERNATIONAL FOOT

CITY OF BEAVERTON **PUBLIC WORKS DEPARTMENT ENGINEERING DIVISION**

1 1/2"

154" [12'-10"]

32"ø INLET HOLE

1 1/2"

1 1/2"

82" [6'-10"]

1 1/2"

DESIGNED BY:	MB	NO.	DATE	REVISION	BY
DRAWN BY:	AB	1	10/06/09	CONSTRUCTION SET - ADJUSTED TO FIT VAULT SHOP DRAWINGS	МВ
CHECKED BY:	MB				
APPROVED BY:	MB				

SW 158TH AVENUE - STORM PRETREATMENT STRUCTURE

VAULT SHOP DRAWINGS

PROJECT:
COSTCO-158th Ave IMPROVEMENTS MARY RYAN 503-258-3112

CONTECH

ORDER NUMBER: N/A

SPECIFYING AGENCY:

SALES PERSON: RHONDA WILLIAMS

I.E. 186.76

N/A

PROJECT NO: DATE: 8/04/09 8073 SHEET NO: 5 of 5

x 24"